MULTI-LOCATION STORM WATER INFRASTRUCTURE

TOWNSHIP OF WILLINGBORO, BURLINGTON COUNTY, NEW JERSEY


BERKSHIRE LANE, CLUBHOUSE DRIVE, HOLSTONE LANE

PREPARED FOR:


OWNER

TOWNSHIP OF WILLINGBORO


1 REV DR MARTIN LUTHER KING JR DRIVE WILLINGBORO, NJ 08046

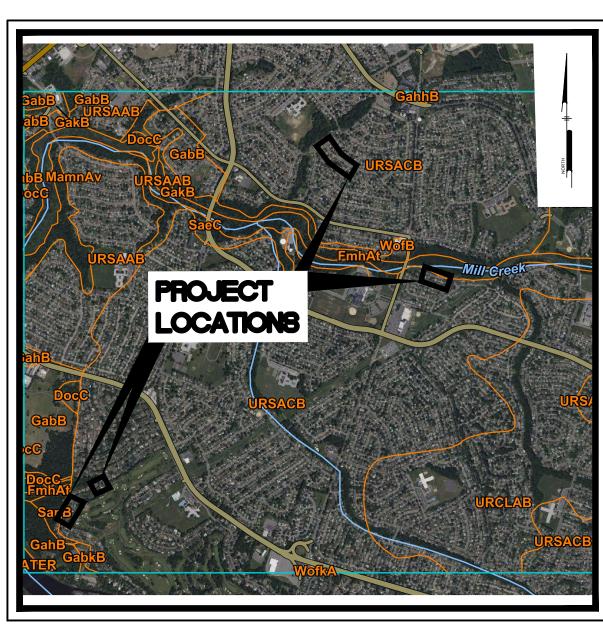

SOILS MAP
Scale: NTS

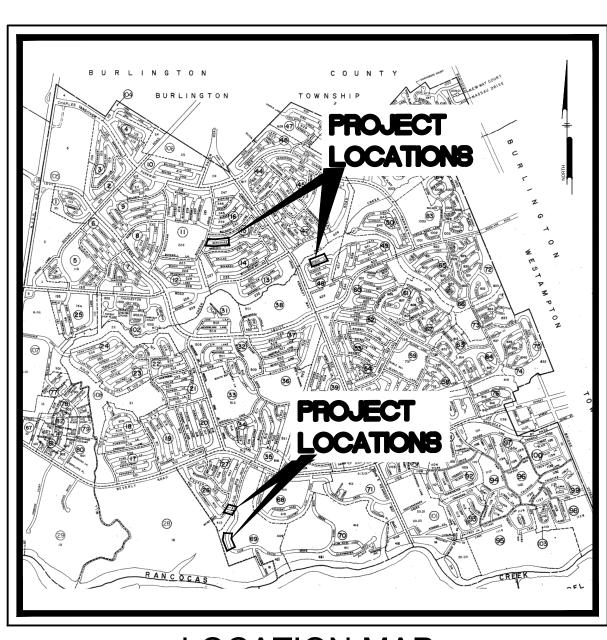

LOCATION MAP
Scale: NTS

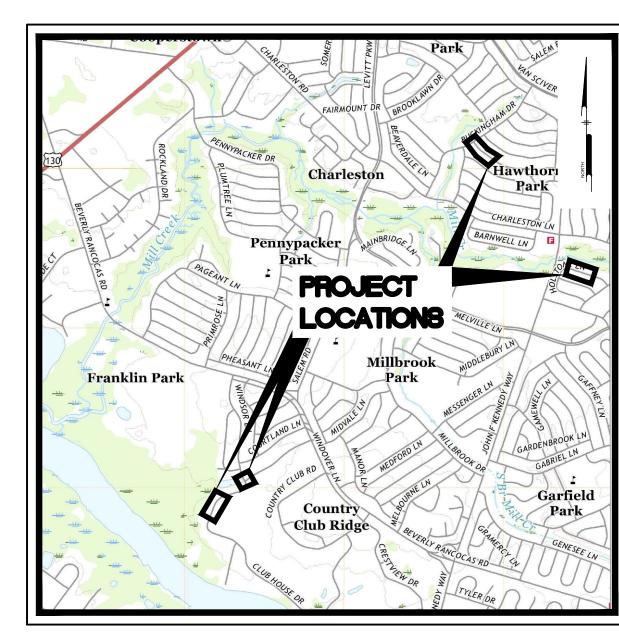

USGS MAP Scale: 1" = 2000'

PREPARED BY:
PENNONI ASSOCIATES INC.



515 Grove Street, Suite 1B Haddon Heights, NJ 08035 **T** 856.547.0505 **F** 856.547.9174



CALL BEFORE YOU DIG 1-800-272-1000

CONTRACTOR SHALL BE RESPONSIBLE TO COMPLY WITH THE REQUIREMENTS OF THE NEW JERSEY ONE-CALL DAMAGE PREVENTION SYSTEM AS STATED IN THE "UNDERGROUND FACILITY PROTECTION ACT".

Pennoni

NGINEER INO. GE34634

HUGH J. DOUGHE
PROFESSIONAL ENGINEE
NEW JERSEY LICENSE NO. GE

TI-LOCATION STORM WATER INFRASTRUC
WILLINGBORO TOWNSHIP, BURLINGBORO TOWNSHIP

WILLINGBORO TOWNSHIP

ALL DOCUMENTS PREPARED BY PENNONI ASSOCIATES
ARE INSTRUMENTS OF SERVICE IN RESPECT OF THE
PROJECT. THEY ARE NOT INTENDED OR REPRESENTED
TO BE SUITABLE FOR REUSE BY OWNER OR OTHERS OF

ALL DOCUMENTS PREPARED BY PENNONI ASSOCIATE ARE INSTRUMENTS OF SERVICE IN RESPECT OF THE PROJECT. THEY ARE NOT INTENDED OR REPRESENTE TO BE SUITABLE FOR REUSE BY OWNER OR OTHERS OF THE EXTENSIONS OF THE PROJECT OR ON ANY OTHE PROJECT. ANY REUSE WITHOUT WRITTEN VERIFICATION OR ADAPTATION BY PENNONI ASSOCIATES FOR THE SPECIFIC PURPOSE INTENDED WILL BE AT OWNERS SOLE RISK AND WITHOUT LIABILITY OR LEGAL EXPOSURE TO PENNONI ASSOCIATE; AND OWNER SHAINDEMNIFY AND HOLD HARMLESS PENNONI ASSOCIATIF FROM ALL CLAIMS, DAMAGES, LOSSES AND EXPENSE

PROJECT WTCEX22025

DATE JUNE 01, 2023

DRAWING SCALE AS NOTED

ARISING OUT OF OR RESULTING THEREFROM.


CM0001

SHEET 1 OF 5

GENERAL NOTES:

- CURB RAMPS AND SIDEWALKS THAT ARE CONSTRUCTED NOT IN COMPLIANCE WITH ADA ACCESSIBILITY REQUIREMENTS INCLUDING MAXIMUM RUNNING SLOPES, MAXIMUM CROSS SLOPES, LANDING AREA LOCATION AND SIZE, DIVERGING SIDEWALK DROP OFF PROTECTION, BLENDED TRANSITIONS, BLENDED TRANSITION RUNNING SLOPES AND CROSS SLOPES, FLARE WIDTHS, GRADE BREAKS AND GRADE BREAK DIRECTIONS, CLEAR SPACE SIZE AND LOCATION, WILL NOT BE
- 2. NJDOT STANDARD SPECIFICATIONS FOR ROAD AND BRIDGE CONSTRUCTION 2019 AND CURRENT AND SUPPLEMENTARY SPECIFICATIONS THERETO GOVERN
- 3. SUPPLEMENTARY SPECIFICATIONS FOR STATE AID PROJECTS APPLY.
- 4. REFER TO CURRENT "NJDOT STANDARD ROADWAY CONSTRUCTION—TRAFFIC CONTROL—BRIDGE CONSTRUCTION DETAILS 2019" FOR ADDITIONAL GUIDANCE.
- 5. ALL DIMENSIONS, QUANTITIES AND EXISTING PHYSICAL CHARACTERISTICS OF THE WORK AREA SHALL BE REVIEWED AND FIELD VERIFIED BY THE CONTRACTOR PRIOR TO SUBMITTING A BID, MATERIAL ORDERING OR FABRICATION OF ANY PART OF THE WORK. ANY DISCREPANCIES SHALL BE IMMEDIATELY BROUGHT TO THE ATTENTION OF THE ENGINEER.
- 6. PRIOR TO THE START OF ANY OF THE CONSTRUCTION THE CONTRACTOR SHALL CALL THE "ONE CALL" NUMBER (1-800-272-1000) FOR UTILITY MARKOUT LOCATION AND NOTIFICATION. THE CONFIRMATION NUMBER SHALL BE GIVEN TO THE ENGINEER PRIOR TO THE COMMENCEMENT OF THE CONSTRUCTION.
- 7. IT IS THE OBLIGATION AND COST OF THE CONTRACTOR TO CONDUCT HIS OWN SUBSURFACE INVESTIGATIONS AS HE MAY DEEM NECESSARY. THIS INVESTIGATION SHALL BE COMPLETED PRIOR TO BID SUBMITTAL TO DETERMINE ANY UNIQUE CONDITIONS OR MATERIALS THAT MAY EXIST WHICH COULD EFFECT THE CONSTRUCTION OR COST. THE CONTRACTOR SHALL IMMEDIATELY NOTIFY THE ENGINEER OF ANY SUCH FINDINGS.
- 8. EXPANSION JOINT MATERIAL SHALL BE 1/2" THICK PREMOLDED BITUMINOUS IMPREGNATED MATERIAL FOR THE FULL DEPTH OF THE THINNER MATERIAL. COST FOR THIS ITEM SHALL BE INCLUDED IN THE UNIT COST OF EITHER SIDEWALK, CURB, OR APRON, WHICHEVER APPROPRIATE, IN THE BID PROPOSAL.
- 9. WHERE NEW SIDEWALK IS TO BE INSTALLED ADJACENT TO EXISTING SIDEWALK, DRIVEWAY, POLE, ETC., AN EXPANSION JOINT SHALL BE PLACED BETWEEN EACH AND THE NEW SIDEWALK ELEVATION SHALL MATCH THAT OF THE EXISTING IMPROVEMENT.
- 10. EXISTING ITEMS NOTED ON THE PLANS FOR REMOVAL ARE INTENDED TO BEGIN AND TERMINATE AT EXISTING JOINTS HOWEVER, WHERE A JOINT DOES NOT EXIST THEN THE CONTRACTOR WILL BE REQUIRED TO "SAW CUT" TO MAKE AN EVEN, STRAIGHT LINE SEPARATION. THE COST OF THIS ITEM SHALL BE INCLUDED IN THE COST FOR EACH UNIT LISTED IN THE APPROPRIATE BID PROPOSAL ITEM.
- 11. EXTREME CARE SHALL BE EXERCISED BY THE CONTRACTOR WHEN REMOVING EXISTING SIDEWALK, CURB OR DRIVEWAY MATERIAL SO AS NOT TO DISTURB ADJACENT IMPROVEMENTS. ADJACENT IMPROVEMENTS DISTURBED DURING REMOVAL OF THE NOTED ITEMS SHALL BE REPLACED AT THE EXPENSE OF THE CONTRACTOR.
- 12. ALL CONCRETE SHALL BE 28 DAY AIR ENTRAINED (3% TO 5%) CONCRETE. CONCRETE COMPRESSIVE STRENGTH OF (F'C) 4000 PSI MINIMUM SHALL BE DEVELOPED UNLESS NOTED OTHERWISE.
- 13. ALL EDGES (VERTICAL/HORIZONTAL) BETWEEN EXISTING PAVEMENT OR NEW/EXISTING CURB AND NEW PAVEMENT SHALL HAVE TACKCOAT APPLIED. COST FOR THIS ITEM SHALL BE INCLUDED IN THE UNIT COST FOR HMA SURFACE COURSE LISTED IN THE BID PROPOSAL.
- 14. MAINTENANCE AND PROTECTION OF TRAFFIC (MPT) AS DEFINED AND DESCRIBED IN THE SPECIFICATION'S SHALL BE STRICTLY FOLLOWED. A DETOUR PLAN SHALL NOT BE PERMITTED. COST FOR THIS ITEM SHALL BE INCLUDED IN THE COST FOR EACH UNIT LISTED IN THE BID PROPOSAL.
- 15. SANITARY SEWER CLEANOUTS IN CONCRETE REPLACEMENT/INSTALLATION AREAS SHALL RECEIVE A CAST IRON STREET BOX WITH "SEWER" LETTERED IN THE LID.
- 16. EXISTING UTILITIES INCLUDING PRIVATE LAWN SPRINKLER HEADS, WATER METER(S), VALVE BOXES, CLEAN OUTS, CURB STOPS, ETC. SHALL BE ADJUSTED TO MATCH THE FINISHED GRADE BY THE CONTRACTOR; COST FOR THIS ITEM SHALL BE INCLUDED IN AND DISTRIBUTED AMONG THE ITEMS IN THE BID PROPOSAL. WHERE UTILITIES OCCUR IN THE CONCRETE AREAS, THE ITEM SHALL BE EITHER "BOXED OUT" AND GROUTED WITH NON—SHRINK GROUT OR RAISED TO FINISHED GRADE THEN THE CONCRETE POURED. THE END RESULT REQUIRED IS THAT NO CHANGE IN ELEVATION SHALL REMAIN AFTER THE CONSTRUCTION IS COMPLETED.
- 17. SIDEWALK AREAS THAT SHALL BE REMOVED AND REPLACED ARE GENERALLY NOTED PHYSICALLY WITH A PAINT SPLOTCH. PRIOR TO THE REMOVAL OF ANY SIDEWALK THE CONTRACTOR SHALL VERIFY WITH THE ENGINEER OR HIS REPRESENTATIVE THE EXACT EXTENT AND QUANTITY.
- 18. CONCRETE SIDEWALK ADJACENT TO PROPOSED HANDICAP RAMPS SHALL BE REPLACED AS NEEDED TO PROVIDE AN ADA-COMPLIANT RAMP.
- 18. ALL MONUMENTS TO BE RESET BY A PROFESSIONAL LAND SURVEYOR LICENSED IN NEW JERSEY.
- 19. CONTRACTOR IS RESPONSIBLE FOR SAW CUTTING ANY EXISTING CONCRETE (EX: FACE FORM POURS) THAT PROTRUDES INTO NEW ROADWAY.
- 20. CONTRACTOR SHALL ENSURE THAT STORMWATER WILL NOT BECOME TRAPPED AT EXISTING DRIVEWAY APRONS.
- 21. STANDARD CONSTRUCTION DETAILS SHALL CONFORM TO THE LATEST REQUIREMENTS OF THE DEPARTMENT OF TRANSPORTATION
- 22. CONTRACTOR SHALL POST AND MAINTAIN ALL EEO AND LABOR NOTICES IN A PROMINENT AND ACCESSIBLE LOCATION WITHIN THE PROJECT LIMITS WHERE THE NOTICES CAN BE EASILY VISIBLE BY THOSE STAFFING THE PROJECT (ATT. 2 D.2.A., STATE AID SPECIFICATIONS). ALL POSTED INFORMATION SHALL BE PRESENTED IN A CLEAR MANNER AND PROTECTED FROM THE WEATHER

EXISTING		PROPOSED	EVIOTI	
		11101 0025	EXISTI	<u>NG</u>
	BUILDING			TELEPHONE HANDHOLE
× ×	FENCE -	xx		TELEPHONE HINOTION POY
	CURB =		<u>TJB</u>	TELEPHONE JUNCTION BOX
	DEPRESSED CURB			TELEPHONE MANHOLE
	SIDEWALK CONCRETE			
	MILL/OVERLAY PAVEMENT	47.3 - 43.1 (44. 4. 1)	TPB	TELEPHONE PANEL BOX
	FULL DEPTH PAVEMENT REPLACEMENT/BASE REPAIR		(\top)	TELEPHONE PEDESTAL
	GRASS INFILL AREA			
		••••••	(ECS	EMERGENCY CALL STATION
	INLET PROTECTION/REPAIR LIMIT OF WORK AREA			SEPTIC TANK
46.34 x	SPOT ELEVATION	46.34 χ	~	
©	IRRIGATION HEAD	•	Ø	UTILITY POLE
•	LIGHT BOLLARD	\$		BUSH
	SIGN	-o-	O	CONIFEROUS TREE
	SIGN POST AND BOARD CABLE TV JUNCTION BOX	- 	₩	
	CABLE TV MANHOLE	(IV)	\odot	DECIDUOUS TREE
©	COMMUNICATIONS MANHOLE	©		STUMP
	COMMUNICATIONS HANDHOLE			
©	FIBER HANDHOLE	@	-0-	FIRE HYDRANT
	FIBER JUNCTION BOX		W	WATER MANHOLE
(G)	FIBER MANHOLE GAS MANHOLE	(f) (g)		
	GAS METER			WATER POST INDICATOR VALVE
©	GAS STUB OUT	\$		SIAMESE / FIRE DEPARTMENT CONNECTION
	GAS VALVE	<u>\(\) \(\)</u>		
	ELECTRICAL HANDHOLE			WATER STUB OUT
3	ELECTRICAL METER	\mathfrak{G}	∞ 4	W4755 V41V5
	ELECTRICAL MANHOLE			WATER VALVE
EPB	ELECTRICAL PANEL BOX	EPB	\Diamond	WATER METER
E	ELECTRICAL PEDESTAL	E		CURB BOX
©	ELECTRICAL STUB OUT	©		SOILE BOX
<i>5</i>	ELECTRICAL STUB OUT	<i>F</i>		UNIDENTIFIED HANDHOLE
(MW)	MONITORING WELL SANITARY SEWER CLEANOUT	(MW)	<u> </u>	
(FM)	SANITARY SEWER CLEANOUT	(FM)	<u> </u>	UNIDENTIFIED JUNCTION BOX
<u>(S)</u>	SANITARY MANHOLE	<u>S</u>	(U)	UNIDENTIFIED MANHOLE
(ST)	STEAM MANHOLE	§1)		
	STORM DRAIN CLEANOUT	•	<u>UPB</u>	UNIDENTIFIED PANEL BOX
(D)	STORM DRAIN MANHOLE	©	U	UNIDENTIFIED PEDESTAL
	STORM DRAIN FLARED END SECTION		~ ✓	
	STORM DRAIN HEADWALL	7		UNIDENTIFIED VALVE
$\langle \rangle$	STORM DRAIN ID	\bigcirc		
	STORM DRAIN INLET			
D	STORM ROOF DRAIN	D		
	STORM STAND PIPE	0		
	STORM DRAIN WING WALL	1		
SHEET# CN			DATE LAST REVIS	SED
2 CN	M0001 COVER SHEET M0002 GENERAL NOTES		6/1/2023 6/1/2023	
	M1001 BERKSHIRE LANE- SITE PLAN 1 M1002 HOLDSTONE, WINDSOR, AND CLUB F	HOUSE - SITE DI AN 2	6/1/2023 6/1/2023	

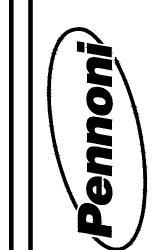

<u>PROPOSED</u>

-O-

PENNONI ASSOCIATE: 515 Grove Street, Suite: Haddon Heights, NJ 080 T 856.547.0505 F 856.54

CREPANCIES BEFORE PROCEEDING WITH WE UGH J. DOUGHERT PROFESSIONAL ENGINEER NEW JERSEY LICENSE NO. GE34634

TER INFRASTRUCTURE
TON COUNTY, NEW JERSEY

VOTES

GENERAL NOTE

DATE NO. REVISIONS BY

ALL DOCUMENTS PREPARED BY PENNONI ASSOCIATES ARE INSTRUMENTS OF SERVICE IN RESPECT OF THE PROJECT. THEY ARE NOT INTENDED OR REPRESENTE TO BE SUITABLE FOR REUSE BY OWNER OR OTHERS O THE EXTENSIONS OF THE PROJECT OR ON ANY OTHEF PROJECT. ANY REUSE WITHOUT WRITTEN VERIFICATIO OR ADAPTATION BY PENNONI ASSOCIATE FOR THE SPECIFIC PURPOSE INTENDED WILL BE AT OWNERS SOLE RISK AND WITHOUT LIABILITY OR LEGAL EXPOSURE TO PENNONI ASSOCIATE; AND OWNER SHALL INDEMNIFY AND HOLD HARMLESS PENNONI ASSOCIATE FORM ALL CLAIMS, DAMAGES, LOSSES AND EXPENSES ARISING OUT OF OR RESULTING THEREFROM.

PROJECT WTCEX22025

DATE JUNE 01, 2023

DRAWING SCALE AS NOTED

APPROVED BY HJD

SHEET 2 OF 5

DRAWN BY

1 Mobilization 2 Excavation, Unclassified (If & Where Directed) 3 HMA 9.5M64 Surface Course, 2" Thick 4 HMA 19M64 Base Course, 4" Thick 5 DGA 6" Thick 6 Concrete Rolled Curb (If & Where Directed) 7 Concrete Vertical Curb (If & Where Directed) 8 Concrete Sidewalk, 4" Thick (If & Where Directed) 9 Jet Clean and TV 18" RCP 10 Jet Clean and TV 24" RCP 11 Heavy Root Clearing, 18" RCP 12 Install 18" CIPP Liner (If & Where Directed) 13 Install 24" CIPP Liner (If & Where Directed) 14 Install 18" HDPE 15 Install 48" HDPE 16 Install End Cap, 18" CMP 17 Repair & Parge Existing Inlet, 2' Depth 18 Manhole Modifications for 48" HDPE Install New Type-B Inlet with New Frame, "ECO" Head, and Bicycle-19 Safe Grate 20 Install Type-B Inlet Frame, "ECO" Head, and Bicycle-Safe Grate 21 Install New Flared End Section 22 Rip Rap Stone, 4" Thick 23 Tree Removal - 6" to 24" Dia

Item #

Base Bid

Description

Quantity

100 SY

96 SY 96 SY

120 LF 40 LF

50 SY

455 LF

719 LF

430 LF

455 LF

719 LF

85 LF


61 LF


1 UN

UN

UN

UN

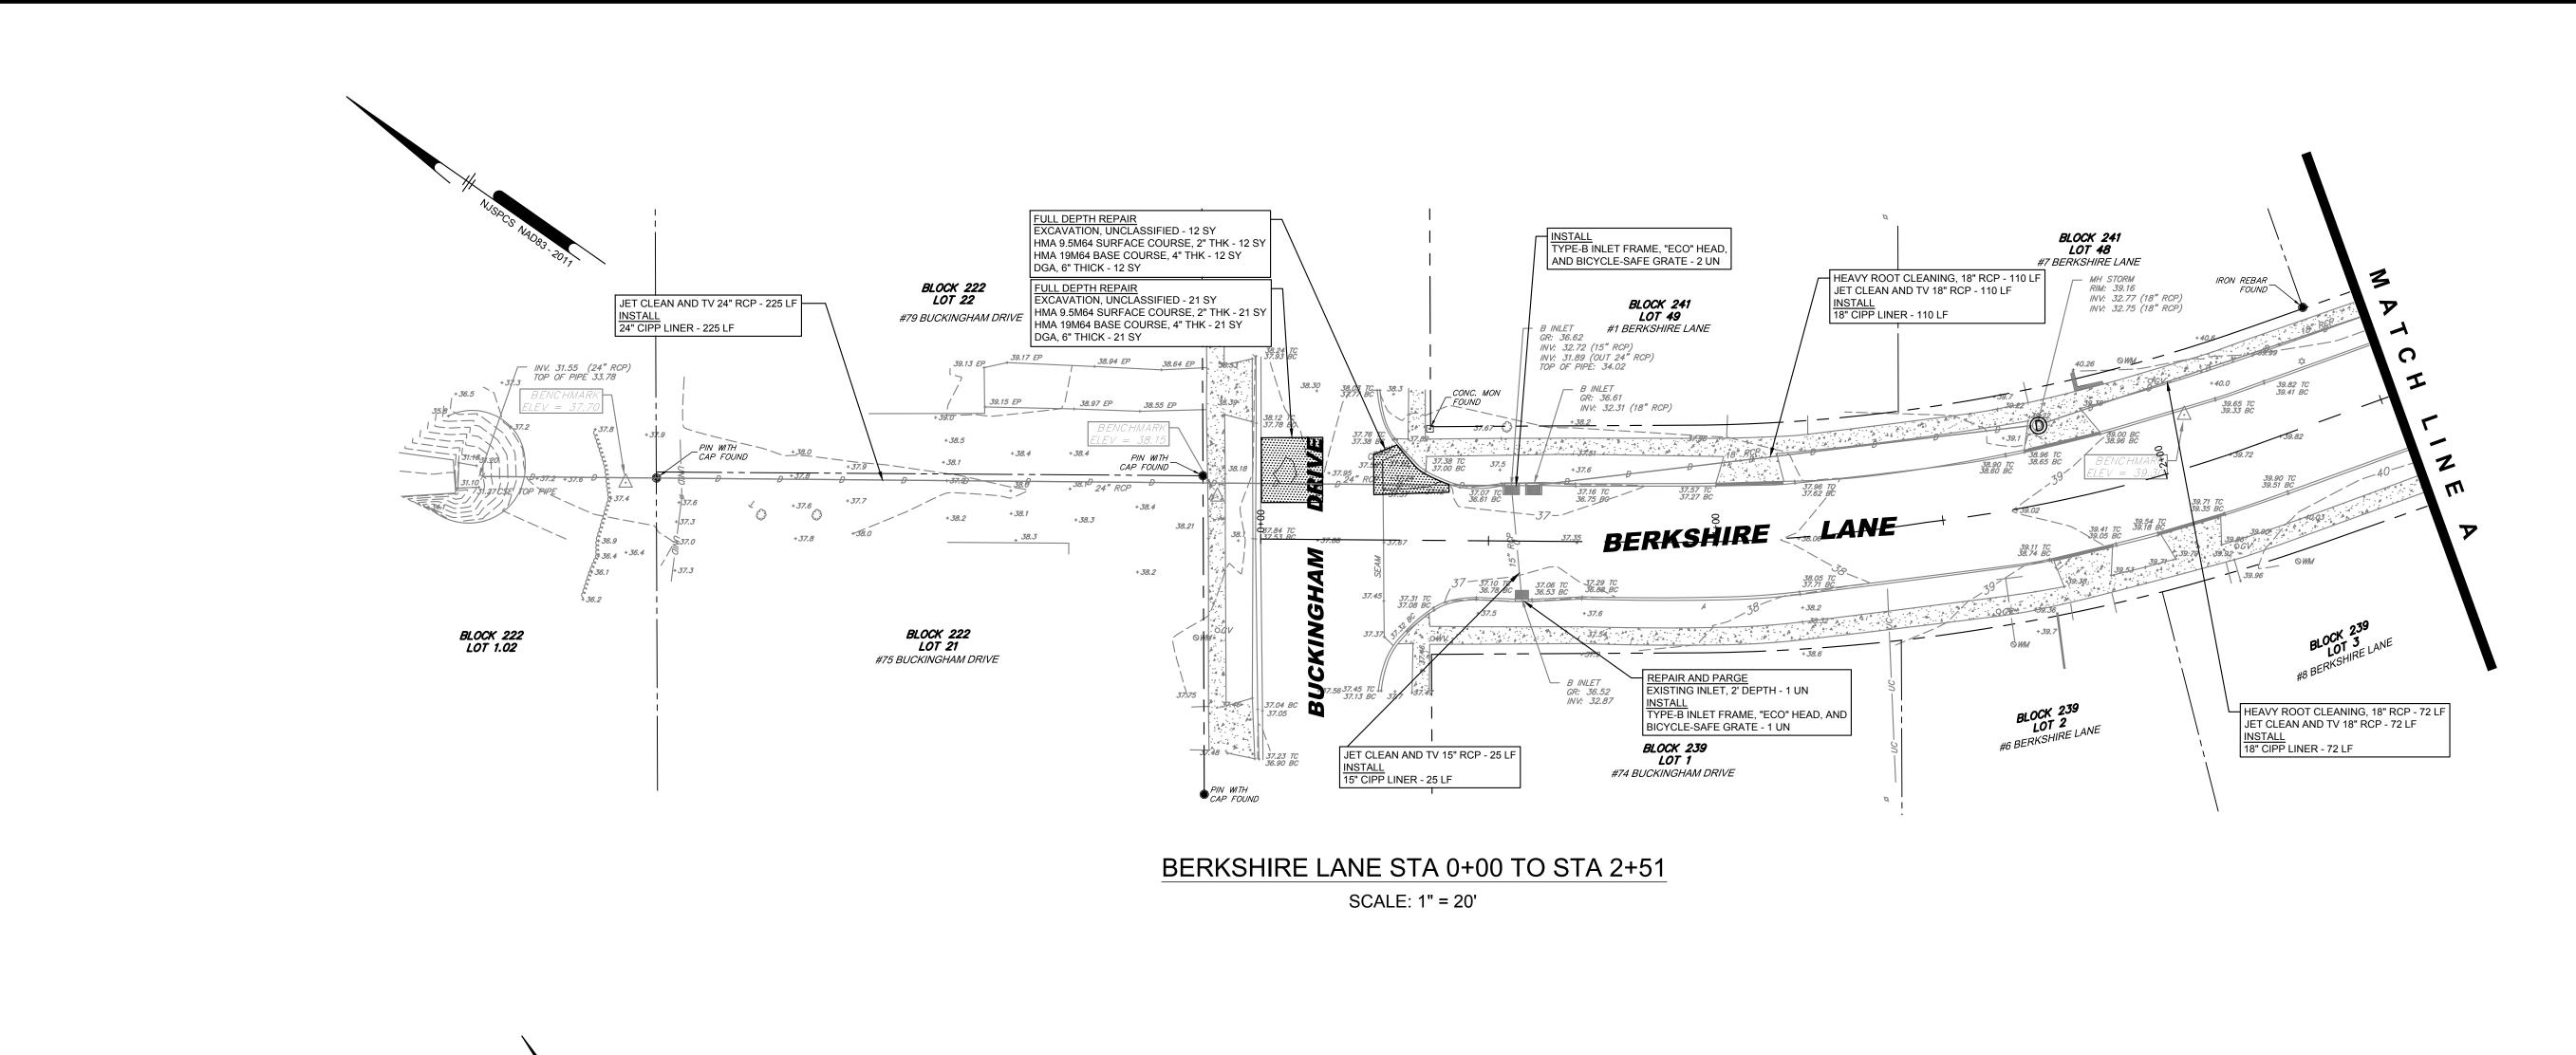

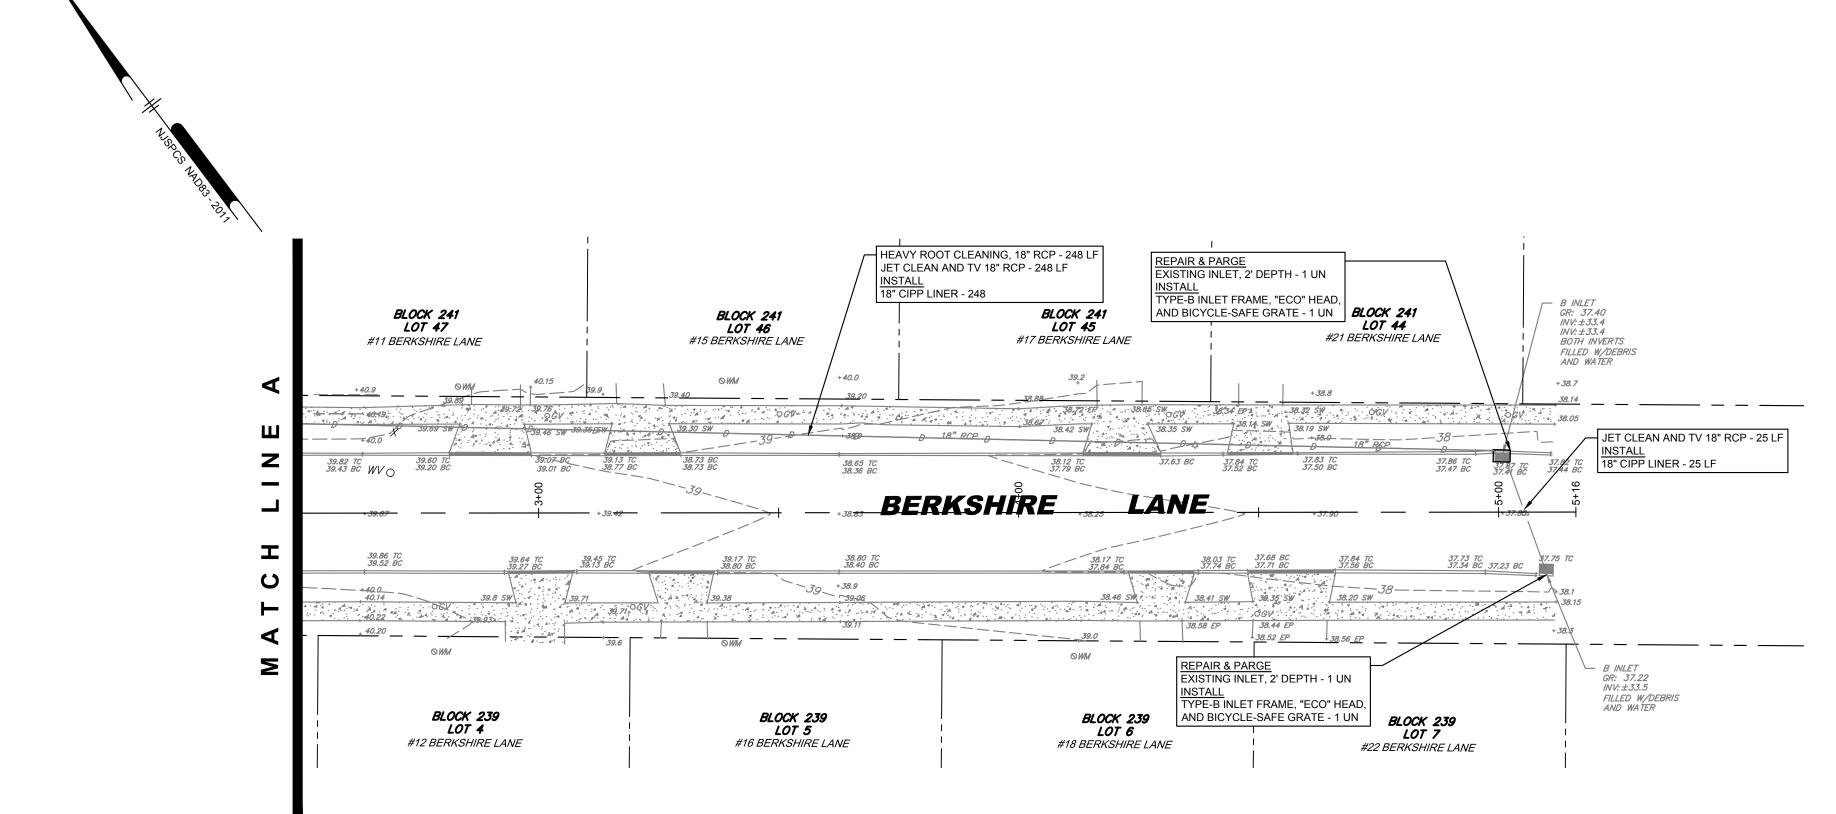

BERKSHIRE LANE STA 2+51 TO STA 5+16


SCALE: 1" = 20'

H. DOUGHERT OFESSIONAL ENGINEER ERSEY LICENSE NO. GE34634 BERKSHIRE ALL DOCUMENTS PREPARED BY PENNONI ASSOCIATES ARE INSTRUMENTS OF SERVICE IN RESPECT OF THE PROJECT. THEY ARE NOT INTENDED OR REPRESENTED TO BE SUITABLE FOR REUSE BY OWNER OR OTHERS ON THE EXTENSIONS OF THE PROJECT OR ON ANY OTHER PROJECT. ANY REUSE WITHOUT WRITTEN VERIFICATION
OR ADAPTATION BY PENNONI ASSOCIATES FOR THE SPECIFIC PURPOSE INTENDED WILL BE AT OWNERS
SOLE RISK AND WITHOUT LIABILITY OR LEGAL INDEMNIFY AND HOLD HARMLESS PENNONI ASSOCIATES FROM ALL CLAIMS, DAMAGES, LOSSES AND EXPENSES ARISING OUT OF OR RESULTING THEREFROM. WTCEX22025 JUNE 01, 2023

CM1001

SHEET 3 OF 5

0 20' 40'

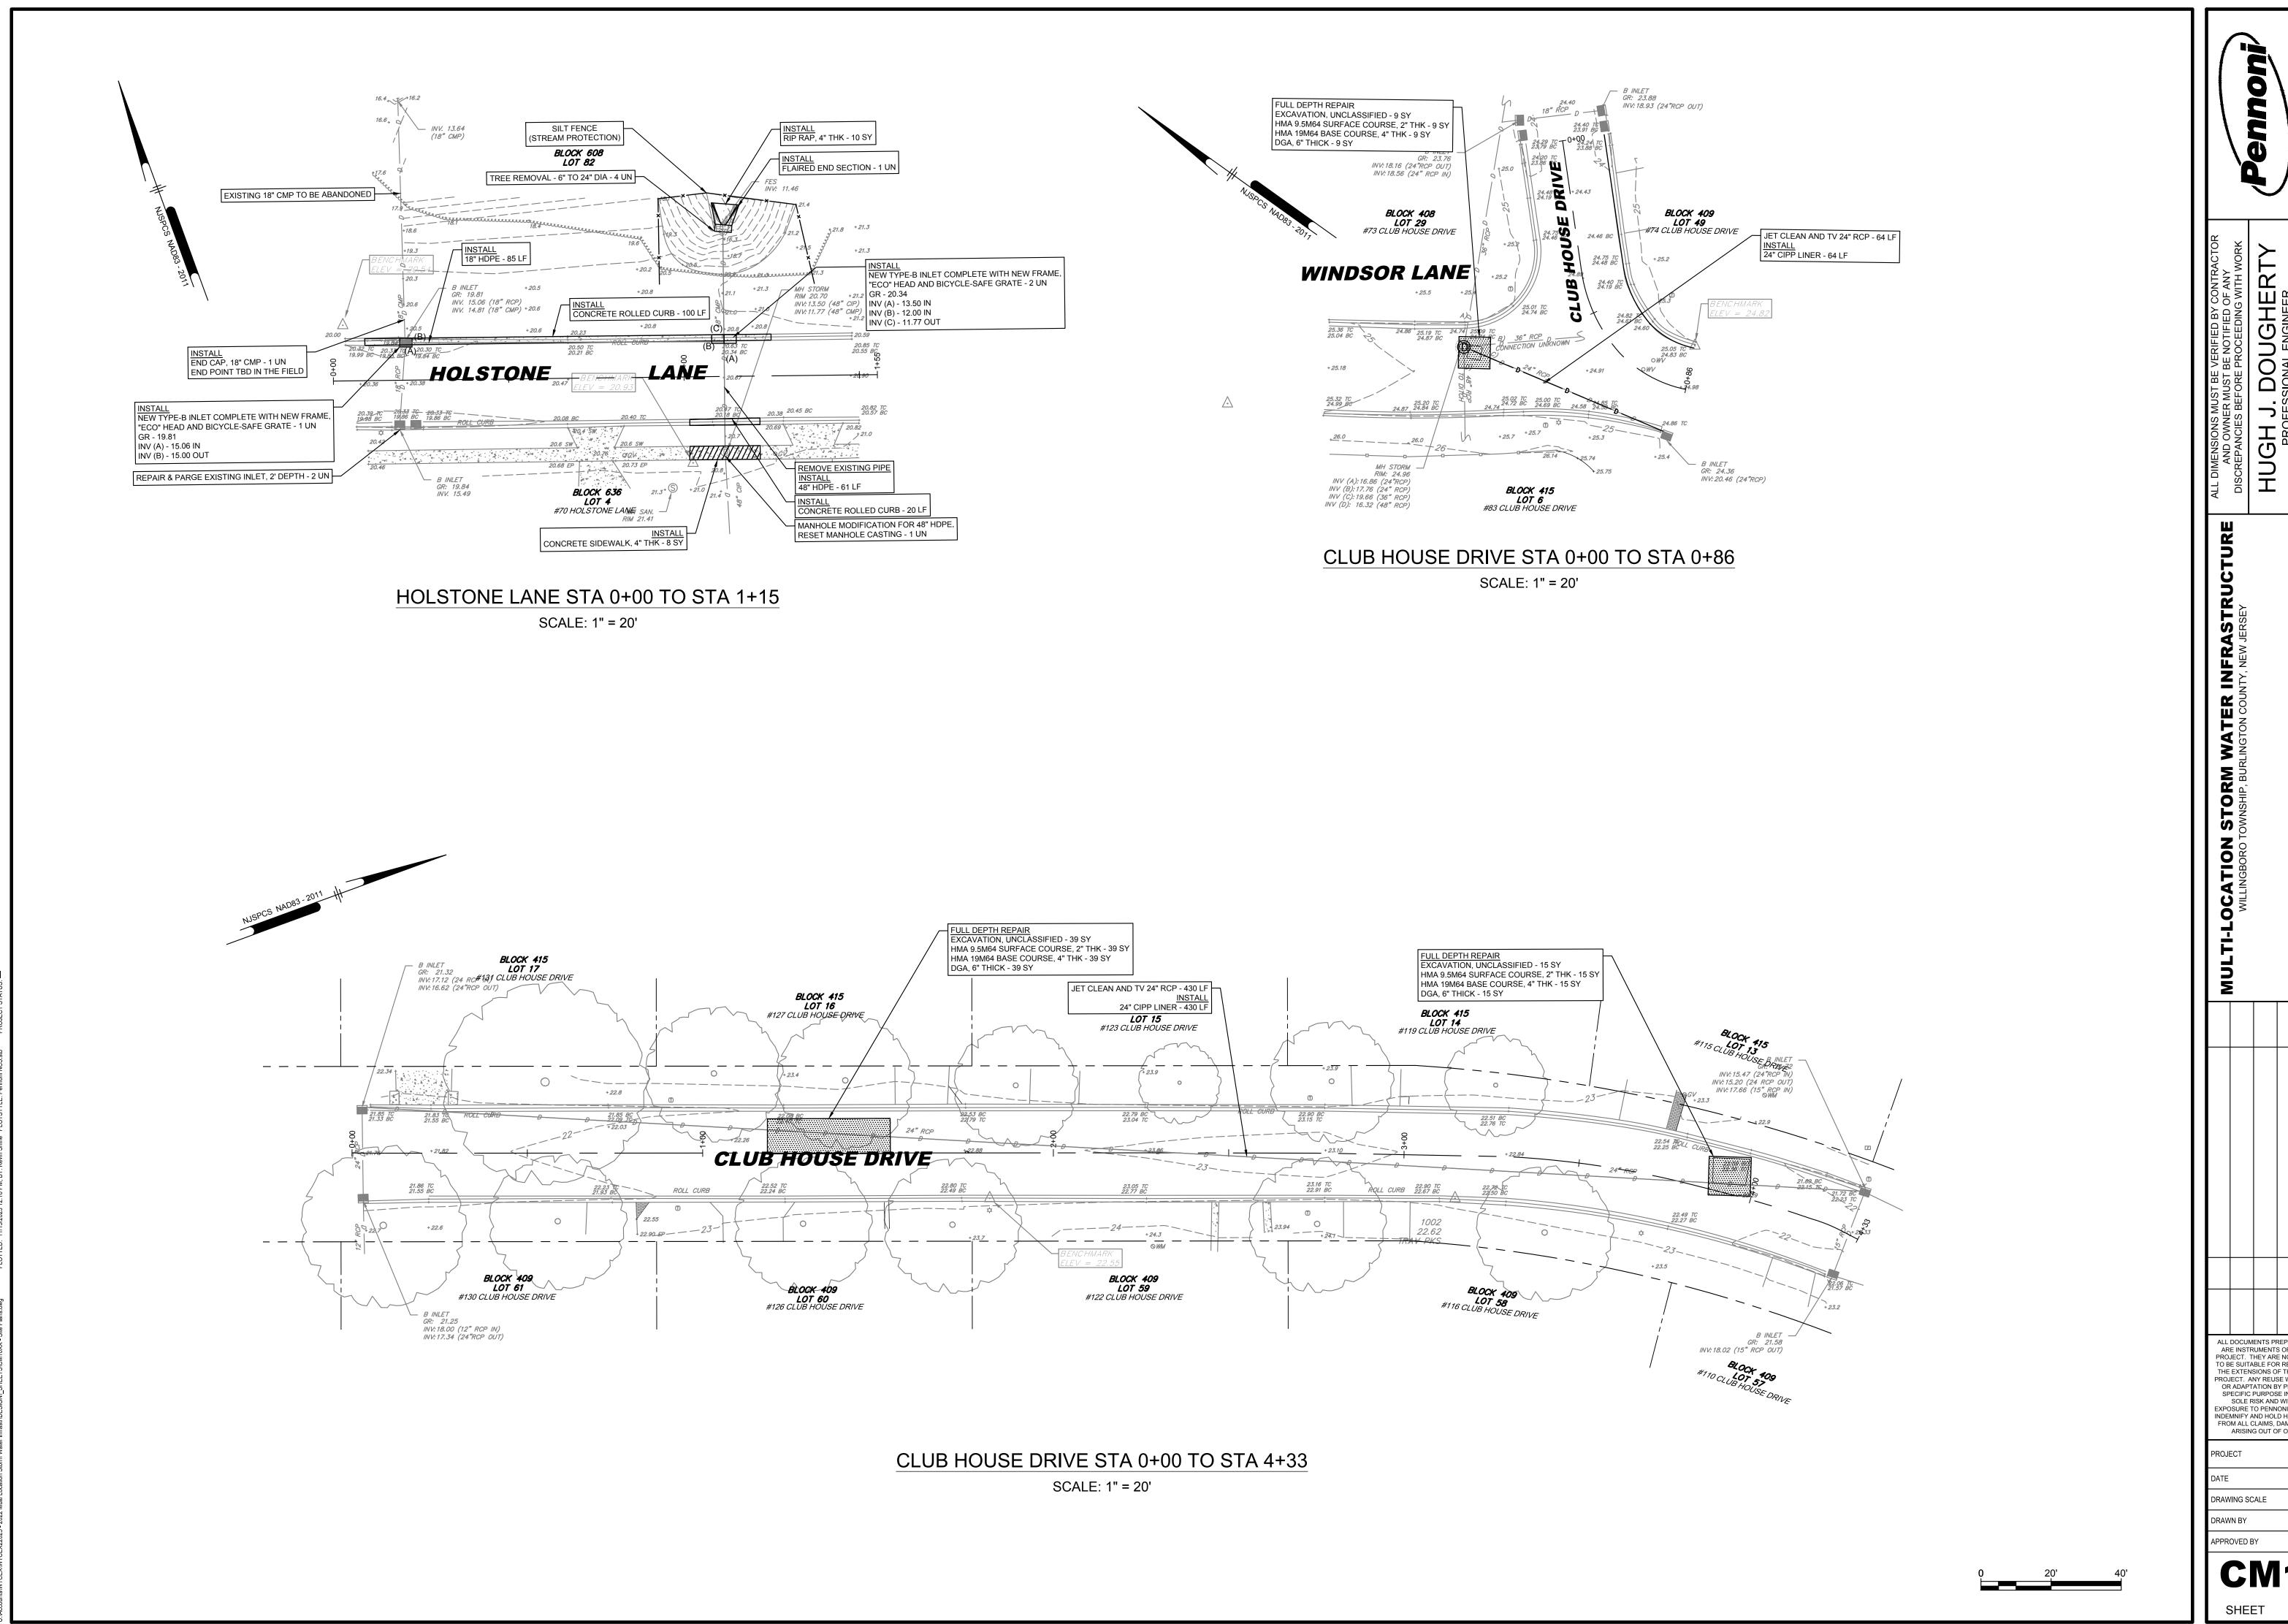


HUGH J. DOUGHERT PROFESSIONAL ENGINEER NEW JERSEY LICENSE NO. GE34634

DRIVE ANS - CLUBHOUSE HOLSTONE LANE

ALL DOCUMENTS PREPARED BY PENNONI ASSOCIATES ARE INSTRUMENTS OF SERVICE IN RESPECT OF THE PROJECT. THEY ARE NOT INTENDED OR REPRESENTED

TO BE SUITABLE FOR REUSE BY OWNER OR OTHERS ON THE EXTENSIONS OF THE PROJECT OR ON ANY OTHER PROJECT. ANY REUSE WITHOUT WRITTEN VERIFICATION OR ADAPTATION BY PENNONI ASSOCIATES FOR THE SPECIFIC PURPOSE INTENDED WILL BE AT OWNERS
SOLE RISK AND WITHOUT LIABILITY OR LEGAL EXPOSURE TO PENNONI ASSOCIATE; AND OWNER SHA INDEMNIFY AND HOLD HARMLESS PENNONI ASSOCIATES FROM ALL CLAIMS, DAMAGES, LOSSES AND EXPENSES ARISING OUT OF OR RESULTING THEREFROM.

WTCEX22025 JUNE 01, 2023 1"=20'

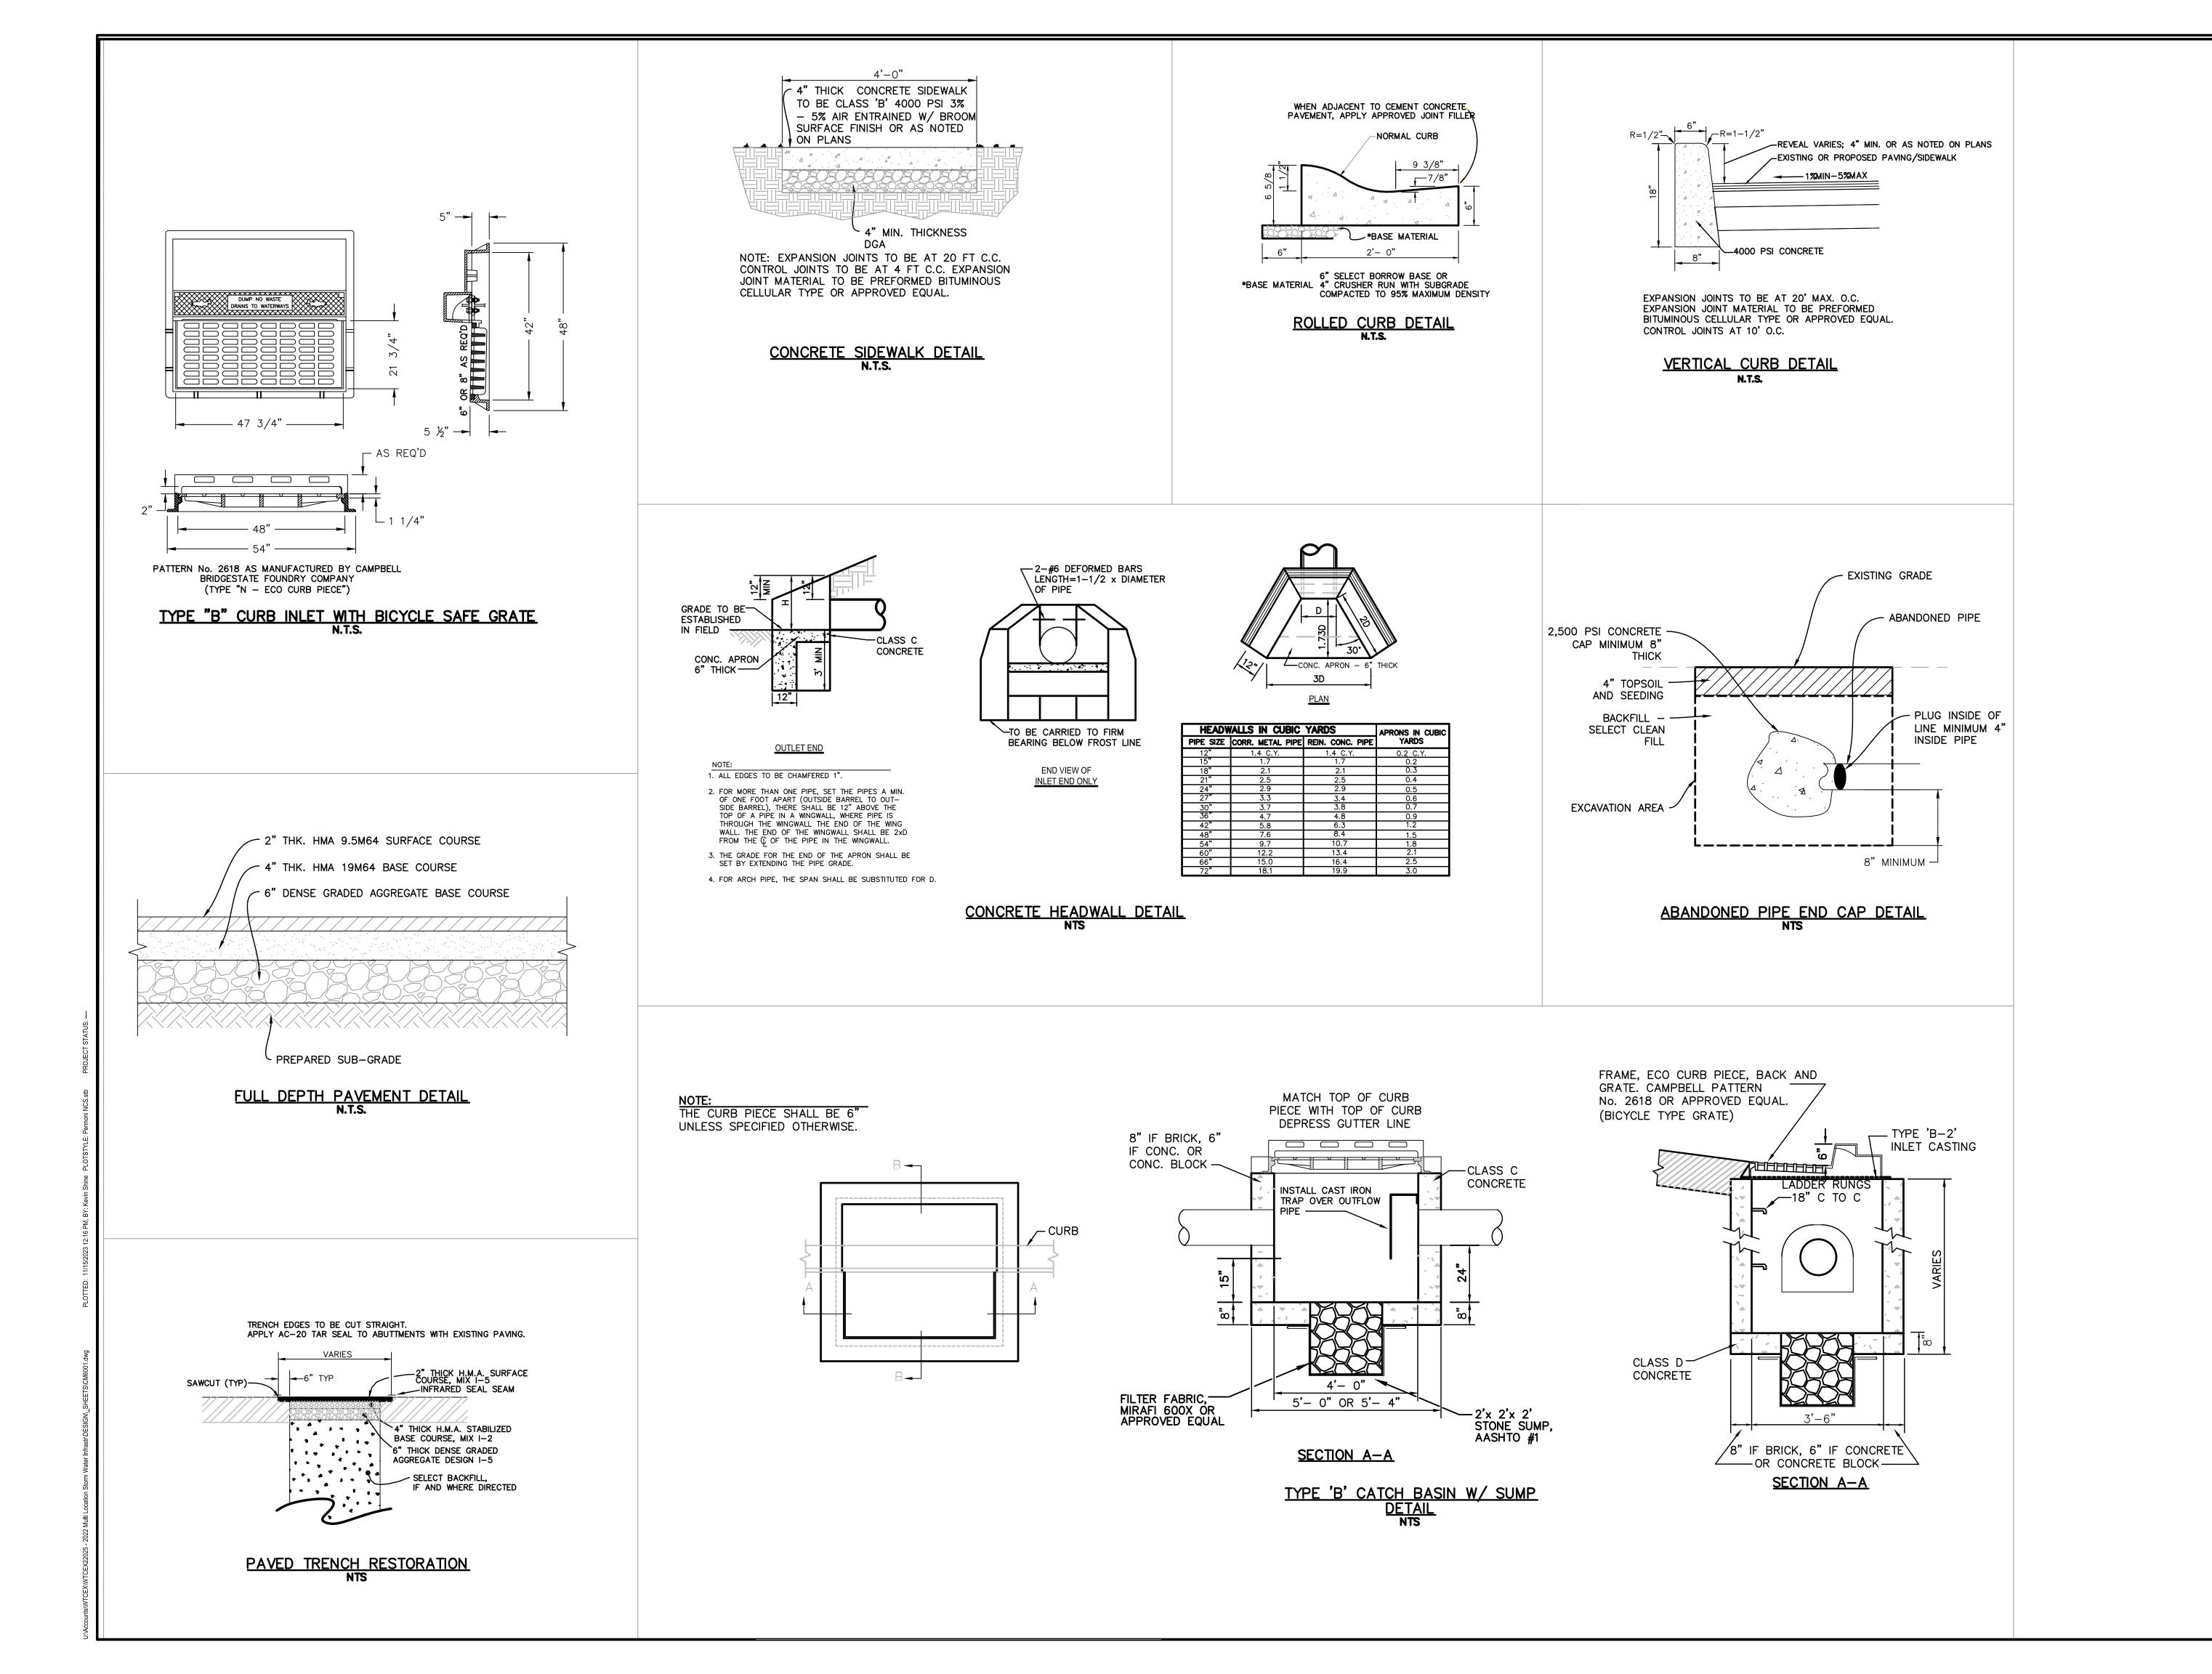

SSIONAL ENGINEER
Y LICENSE NO. GE34634

J. HOGH

> DE NOIL

ALL DOCUMENTS PREPARED BY PENNONI ASSOCIATE ARE INSTRUMENTS OF SERVICE IN RESPECT OF THE PROJECT. THEY ARE NOT INTENDED OR REPRESENTE TO BE SUITABLE FOR REUSE BY OWNER OR OTHERS ON THE EXTENSIONS OF THE PROJECT OR ON ANY OTHER PROJECT. ANY REUSE WITHOUT WRITTEN VERIFICATION OR ADAPTATION BY PENNONI ASSOCIATES FOR THE SPECIFIC PURPOSE INTENDED WILL BE AT OWNERS SOLE RISK AND WITHOUT LIABILITY OR LEGAL XPOSURE TO PENNONI ASSOCIATE; AND OWNER SHA INDEMNIFY AND HOLD HARMLESS PENNONI ASSOCIATES FROM ALL CLAIMS, DAMAGES, LOSSES AND EXPENSES ARISING OUT OF OR RESULTING THEREFROM.

WTCEX22025 JUNE 01, 2023 N.T.S DRAWN BY

CM6001

APPROVED BY